# SORENSEN CALDON FERRIS BUILDERS

**CUSTOM DESIGN HOMES** 

## PROPOSED RESIDENCE FOR:

Mr. & Mrs. Griffin

Lot 1, No.7, Ferry Road, Croki. N.S.W. 2430 D.P.770821 00 COVER SHEET

01 SITE PLAN

02 FLOOR PLAN


02A SUBFLOOR PLAN

03 ELEVATIONS

04 ELEVATIONS

05 SECTIONS

06 PERSPECTIVES

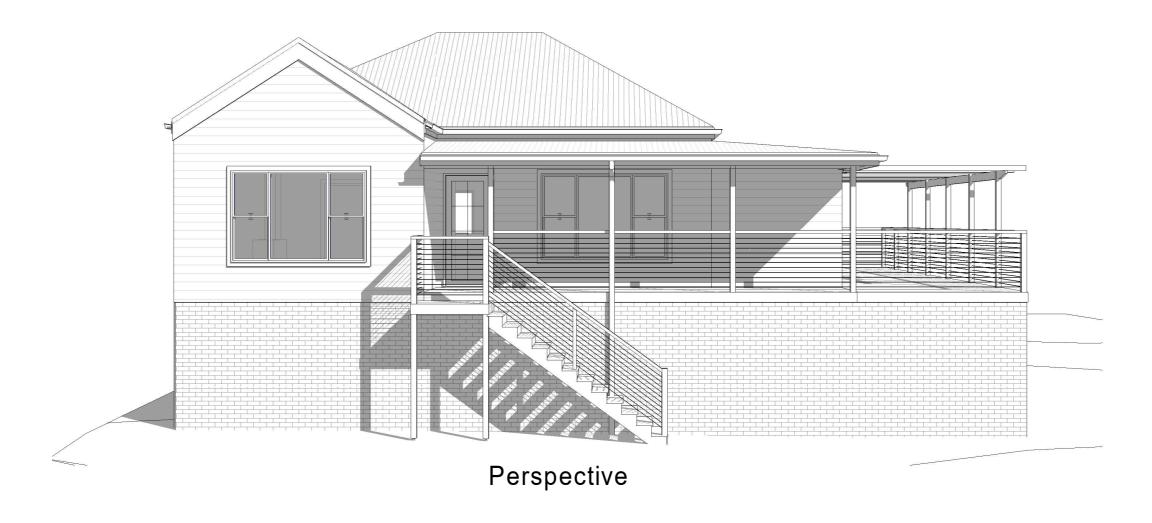

JTRACTS/SORENSON/13-381-GRIFFINIREVIT/13-381-GRIFFIN.rvt

## This drawing remains the property of sorensen caldon ferris sullders and is provided for the use as described and may not be used or reproduced in whole or in part without written permission. ALL WRITTEN DIMENSIONS TAKE PRECEDENCE OVER SCALE. BUILDER TO VERIFY ALL DIMENSIONS PRIOR TO COMMMENCING CONSTRUCTION. NOTIFY DESIGNER OF ANY DISCREPANCIES BEFORE PROCEEDING. PETER NIKSIC DESIGN & DRAFTING PROPOSED NEW RESIDENCE BASIX CERT. No. SCA

ISSUE TO COUNCIL

REV DESCRIPTION

DATE

DOMESTIC, SOLAR PASSIVE DESIGN,
3D IMAGES

MOBILE: 0421 749 553

SORENSEN CALDON FERRIS BUILDERS

CUSTOM DESIGN HOMES
Taree Office (02) 6551 0445

FOR Mr. & Mrs. Griffin


AT Lot 1, No.7, Ferry Road,


Croki. N.S.W. 2430

D.P.770821


BASIX CERT. No.		SCALE	,
		DATE	12-08-25
	PLAN	DRAWN	Author
	Custom Design	CHECKED	Approver
	TITLE COVER SHEET	JOB No.	DWG No.



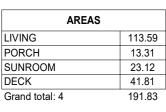


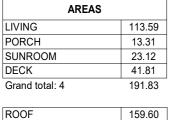

100mm

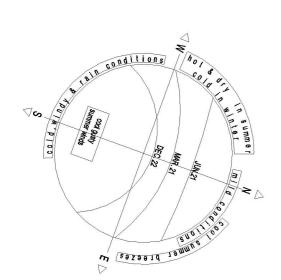



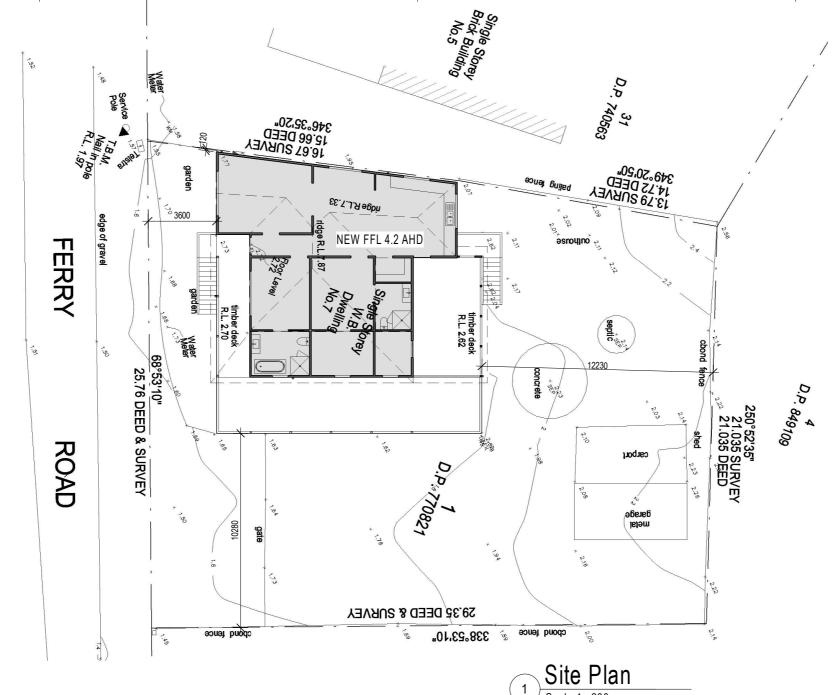

200mm

## SEDIMENT CONTROL NOTES

1. ALL EROSION AND SEDIMENTATION CONTROL MEASURES, INCLUDING REVEGETATION AND STORAGE OF SOIL AND TOPSOIL, SHALL BE

2. ALL DRAINAGE WORKS SHALL BE CONSTRUCTED AND STABILIZED AS DISTURBED EARLY AS POSSIBLE DURING DEVELOPMENT. 3. SEDIMENT TRAPS SHALL BE CONSTRUCTED AROUND ALL INLET


4. ALL SEDIMENT BASINS AND TRAPS SHALL BE CLEANED WHEN THE STRUCTURES ARE A MAXIMUM OF 60 % FULL OF SOIL MATERIALS, E INCLUDING THE MAINTENANCE PERIOD. 5. ALL DISTURBED AREAS SHALL BE REVEGITATED AS SOON AS THE

CONSISTING OF 300mm WIDE X 300mm DEEP TRENCH.

RELEVANT WORKS ARE COMPLETED.

6. SOIL AND TOPSOIL STOCKPILES SHALL BE LOCATED AWAY FROM DRAINAGE LINES AND AREA WHERE WATER MAY CONCENTRATE.

7. FILTER SHALL BE CONSTRUCTED BY STRETCHING A FILTER FABRIC (PROPEX OR APPROVED EQUIVALENT BETWEEN POST AT 3.0m CENTRES. FABRIC SHALL BE BURIED 150mm ALONG ITS LOWER

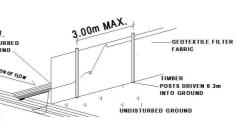

SEDIMENT FENCE

Current FFL 2.72 AHD New FFL 4.2 AHD minimum 1:100 3.9AHD a

300mm

FPL4 - Probable max	5.5 m AHD	The highest flood level that could conceivably occur
flood level		at this location
1% AEP flood level in Year 2010	2.8 m AHD	This level is useful for insurance purpose, refer to your insurance policy and the Insurance Contracts Regulation 1985 (Cwealth)
FPL2 - 1% AEP Flood Level in Year 2100	3.4 m AHD	Adopted 1% flood level
FPL3 - Flood Planning Level	3.9 m AHD	Adopted 1% flood level plus 0.5m freeboard
FPL1 - 5% AEP Flood Level	2.0 m AHD	

ALL WRITTEN DIMENSIONS TAKE PRECEDENCE OVER SCALE. BUILDER TO VERIFY ALL DIMENSIONS PRIOR TO COMMMENCING CONSTRUCTION. NOTIFY DESIGNER OF ANY DISCREPANCIES BEFORE PROCEEDING

3-3		COPYRIGHT 2025		
NO				
TS\SORENSON\13				
SOF.				
ACTS				
Æ				
CONTI		ISSUE TO COUNCIL	12-08-25	
₹	REV	DESCRIPTION	DATE	



## EST 1958 **SORENSEN CALDON FERRIS BUILDERS**


CUSTOM DESIGN HOMES Taree Office (02) 6551 0445


FOR Mr. & Mrs. Griffin	
AT Lot 1, No.7, Ferry Ro Croki. N.S.W. 2430 D P 770821	ac
D.1. 1.1. 302 1	


PROPOSED NEW RESIDENCE

BASIX CERT. No. SCALE	As indicated
DATE	12-08-25
PLAN DRAWN	P.N.
Custom Design CHECKED	M.H.
TITLE SITE PLAN	DWG No.



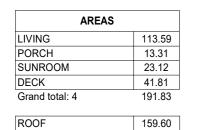

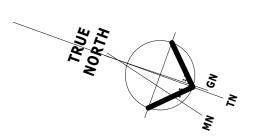

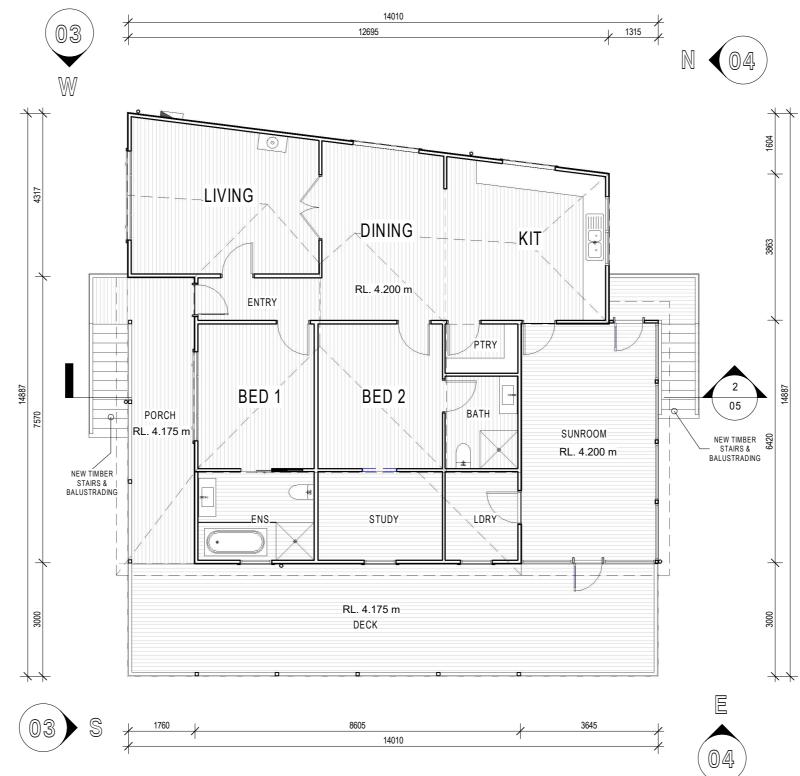

Ground Floor Plan
Scale 1: 100

Current FFL 2.72 AHD New FFL 4.2 AHD minimum 1:100 3.9AHD a

350P	350mm ENGAGED BRICK PIERS @ 1500 CTRS
	MAX
720L	DOOR WITH LIFT OFF HINGES
ACD	AIR CONDITIONER CONDENSOR
ACD	A/C DUCT: PARTICLE BOARD 250 X 250mm INTERNAL DIMENSIONS
BAL	1000mm HIGH BALUSTRADE
BG	BOX GUTTER TO DETAIL
BH	BULKHEAD-HEIGHT AS NOTED
ВО	BEAM OVER TO STRUCTURAL ENGINEER'S DETAIL
CCO	COLOURED CONCRETE- REFER TO SPEC.
CSD	CAVITY SLIDER DOOR
DP	DOWNPIPE
DPS DTR	DOWNPIPE & SPREADER  DOUBLE TOWEL RAIL TR-TOWEL RAIL
DWP	DISHWASHER PROVISION
EXH/E	EXHAUST VENT TO EAVE
EXH/W	EXHAUST VENT TO WALL
FFL	FINISHED FLOOR LEVEL
FJ FSL	ASSUMED FLOOR JOIST DIRECTION FINISHED SLAB LEVEL
GB	GLASS BLOCKS - NON-FIRE RATED
GBR	GLASS BLOCKS - FIRE RATED
GDP	GARAGE DOOR - PANELLED
GFL	GARAGE FLOOR LEVEL GAS METER
GM HH	HEAD OF OPENING-HEIGHT AS NOTED
HRL	1000mm HIGH HANDRAIL
HWS	HOT WATER SERVICE
INS	SOUND PROOFING TO DETAIL
JUL JUL	METAL FRAMER HILLET RALCONY
LBO	METAL FRAMED JULIET BALCONY LINE OF BUILDING OVER
LHW	LOW HEIGHT WALL-HEIGHT AS NOTED
LWC	LIGHTWEIGHT CLADDING-REFER TO SPEC.
MB	RECESSED ELECTRICAL METER BOX
MH MR-3°	CEILING MANHOLE  METAL ROOF - PITCH AS NOTED
MSD	MIRROR SLIDING DOOR
MW	MICROWAVE SPACE
OF	OVERFLOW
OH P	OVERHEAD CUPBOARDS PAVING-REFER TO SPEC.
RB-90	90mm RECESSED BRICKWORK
RH	RANGEHOOD (RECIRCULATING)
RWO	RAIN WATER OUTLET
S	SPOUT
SA S/D	SMOKE ALARM SETDOWN
SH	SOAP HOLDER
SP	STEEL POST TO ENGINEER'S DETAIL
ST	SERVICES STACK
т	TILED AREA TAP
T TD	TIMBER DECK
	TIMBER FLOORING
ТВ	TIMBER BEAM OVER TO TIMBER
TD.	MANUFACTURER'S DETAIL
TPC	TIMBER POST- (REFER TO ENG'S DWG.) TIMBER PERGOLA TO DETAIL
TPG TRH	TOILET ROLL HOLDER
TR-25°	TILED ROOF - PITCH AS NOTED
TS	TIMBER STAIRS AND LANDING
UBO	UNDER BENCH OVEN
USS VJ	UNDER STAIR STORAGE VERTICAL CONTROL JOINT
VJ-F	FIRE RATED VERTICAL CONTROL JOINT TO
	DETAIL DT-646
WM	WASHING MACHINE SPACE
WO	WALL OVEN
NOTE:	
	PIPES TO BUILDING CORNERS ARE TO BE LOCA
	FROM THE CORNER OF THE EXTERNAL WALL T E OF THE DOWNPIPE.
<u> </u>	CEILING CEILING FAN

THIS DRAWING REMAINS THE PROPERTY OF SORENSEN CALDON FERRIS BUILDERS AND IS PROVIDED FOR THE USE
AS DESCRIBED AND MAY NOT BE USED OR REPRODUCED IN WHOLE OR IN PART WITHOUT WRITTEN PERMISSION

ALL WRITTEN DIMENSIONS TAKE PRECEDENCE OVER SCALE. BUILDER TO VERIFY ALL DIMENSIONS PRIOR TO COMMMENCING CONSTRUCTION. NOTIFY DESIGNER OF ANY DISCREPANCIES BEFORE PROCEEDING

DOMESTIC, SOLAR PASSIVE DESIGN, 3D IMAGES
MOBILE: 0421 749 553

SORENSEN CALDON FERRIS BUILDERS

EST 1958


CUSTOM DESIGN HOMES
Taree Office (02) 6551 0445


FOR Mr. & Mrs. Griffin


AT Lot 1, No.7, Ferry Road,
Croki. N.S.W. 2430
D.P.770821


PROPOSED NEW RESIDENCE

BASIX CERT. No.	SCALE	1:100
	DATE	12-08-25
PLAN	DRAWN	P.N.
Custom Design	CHECKED	Approver
TITLE FLOOR PLAN	JOB No.	DWG No.

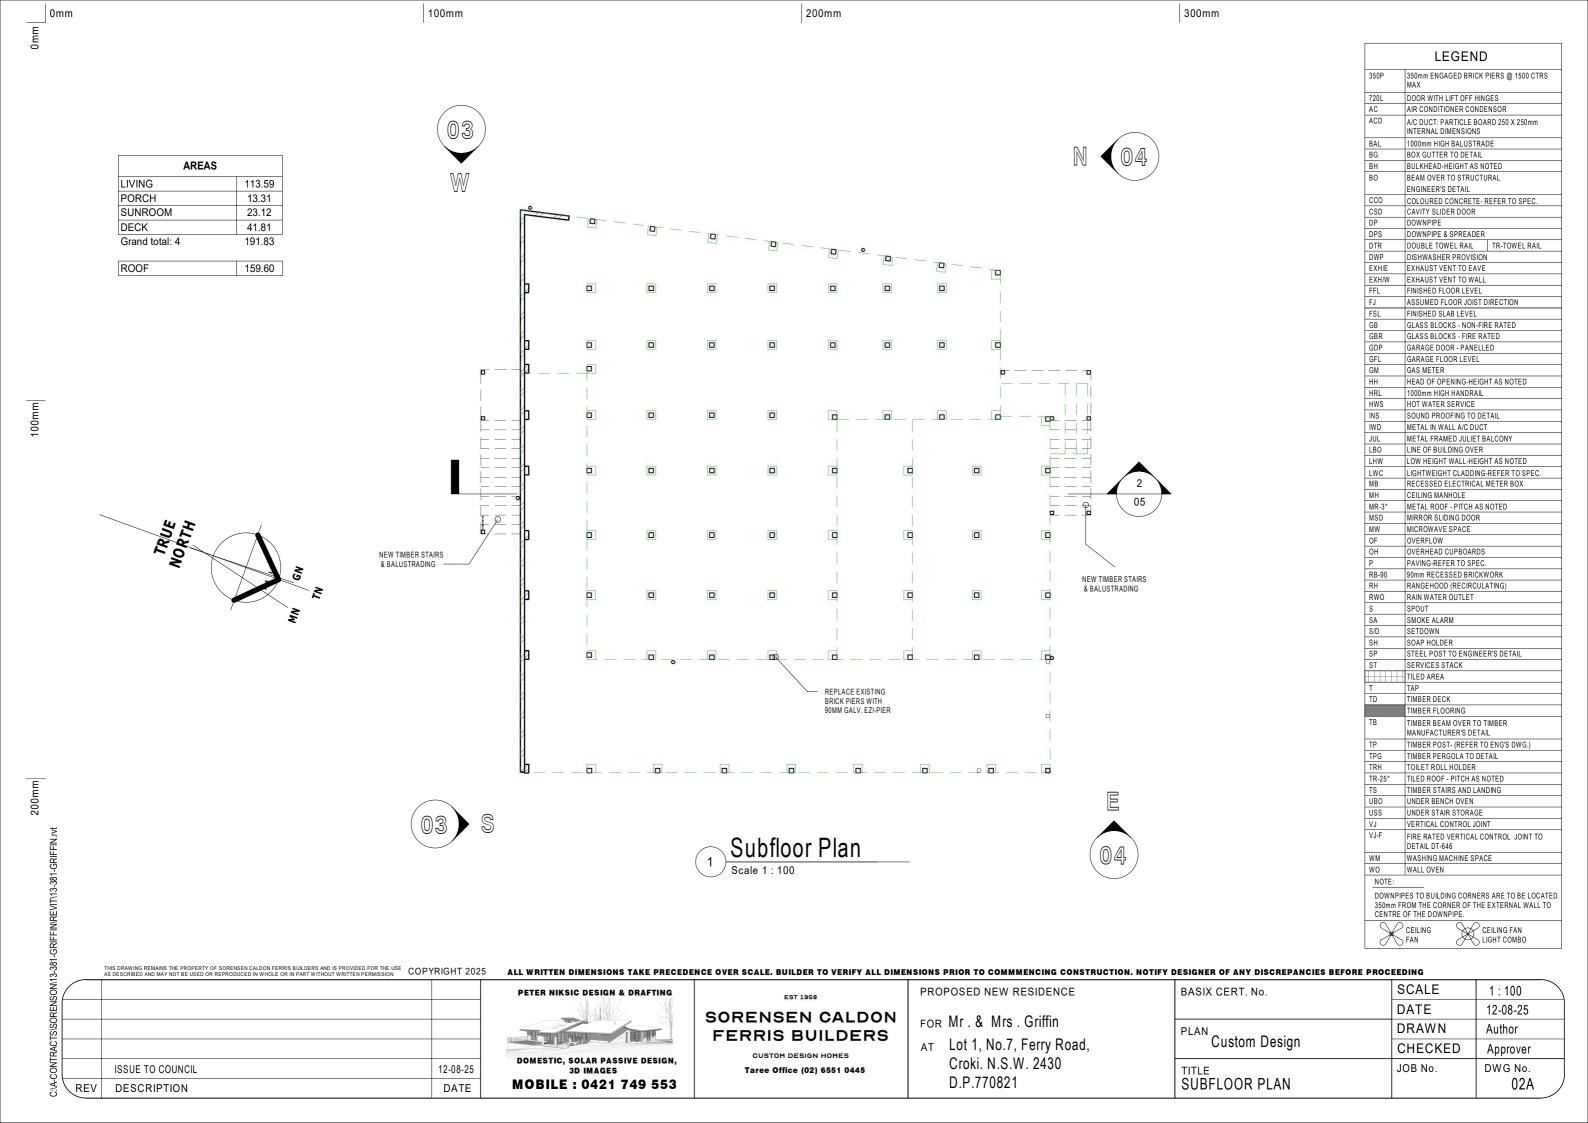

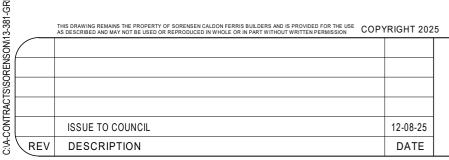

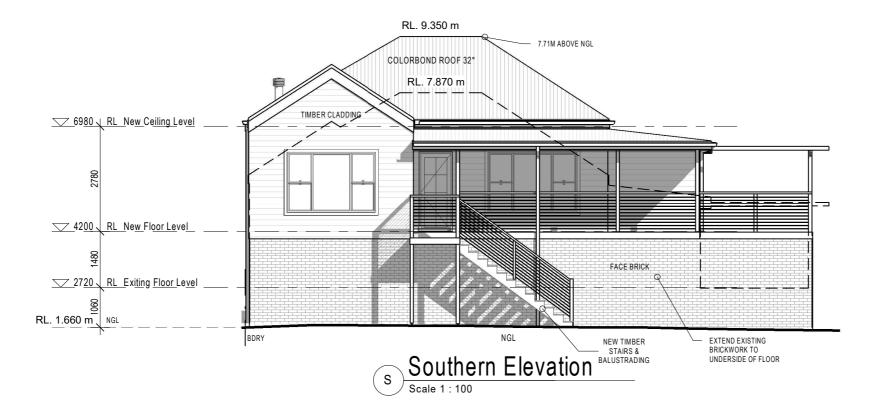

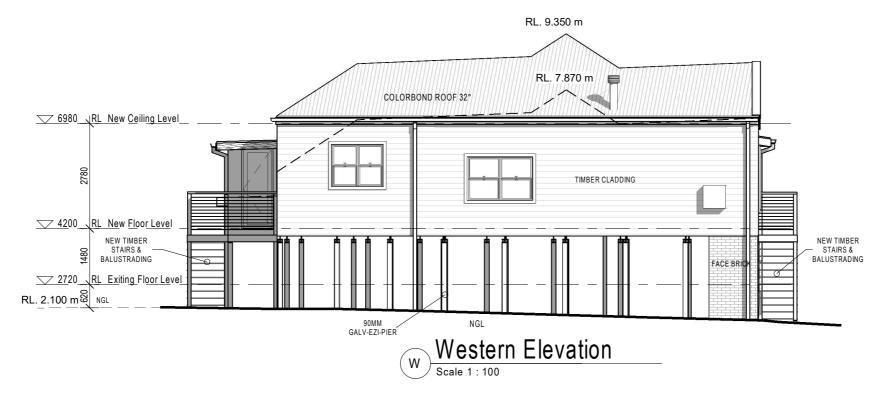

	LEGEND
350P	350mm ENGAGED BRICK PIERS @ 1500 CTRS MAX.
AC	AIR CONDITIONER CONDENSOR
BAL	1000mm HIGH BALUSTRADE
BG	BOX GUTTER TO DETAIL
BOE	BRICK ON EDGE
BW	BRICKWORK - REFER TO EXTERNAL FINISHES SCHEDULE FOR SPEC.
BWR	BRICKWORK RENDERED- REFER TO EXTERNAL FINISHES SCHEDULE FOR SPEC.
СВ	CORBEL BRICK BAND-PROJECTION AS NOTED
CCO	COLOURED CONCRETE - REFER TO EXTERNAL FINISHES SCHEDULES FOR SPEC.
CWL	ROOF COWL
DEB	DROP EDGE BEAM TO STRUCTURAL ENGINEER'S DETAIL
DP	DOWNPIPE
DPS	DOWNPIPE & SPREADER
EGL	EXISTING GROUND LINE
EXH/E	EXHAUST VENT TO EAVE
EXH/W	EXHAUST VENT TO WALL
FCL	FINISHED CEILING LEVEL
FFL	FINISHED FLOOR LEVEL
FL	FLASHING - REFER TO EXTERNAL FINISHES SCHEDULE FOR SPEC
FGL	FINISHED GROUND LEVEL
FSL	FINISHED SLAB LEVEL
GB	GLASS BLOCKS - NON-FIRE RATED
GBR	GLASS BLOCKS - FIRE RATED
GDP	GARAGE DOOR - PANELLED
GFL	GARAGE FLOOR LEVEL
GM	GAS METER
HRL	1000mm HIGH HANDRAIL
HWU	HOT WATER SERVICE
JUL	METAL FRAMED JULIET BALCONY
LWC	LIGHTWEIGHT CLADDING - REFER TO EXTERNAL FINISHES SCHEDULES FOR SPEC.
MB	RECESSED ELECTRICAL METER BOX
MR-3°	METAL ROOF - PITCH AS NOTED
OF	OVERFLOW
0/H	OVERHANG - LENGTH AS NOTED
P	PAVING-REFER TO EXTERNAL FINISHES
	SCHEDULE FOR SPEC.
RB-90	90mm RECESSED BRICKWORK
RCF	REINFORCED CONCRETE FOOTING TO
RCS	STRUCTURAL ENGINEER'S DETAILS REINFORCED CONCRETE SLAB TO
	STRUCTURAL ENGINEER'S DETAIL
RWO	RAIN WATER OUTLET
SC	BRICK SOLDIER COURSE
S/D	SETDOWN
SP	STEEL POST TO ENGINEER'S DETAIL
TD	TIMBER DECK
TFJ	TIMBER FLOOR JOISTS TO MANUFACTURER'S SPECIFICATION
TP	TIMBER POST-(REFER TO ENG'S DWG.)
TPG	TIMBER PERGOLA TO DETAIL
TR-25°	TILED ROOF - PITCH AS NOTED
TS	TIMBER STAIRS AND LANDING
TTR	TIMBER TRUSSED ROOF TO MANUFACTURERE'S SPECIFICATION
VJ	VERTICAL CONTROL JOINT
VJ-F	FIRE RATED VERTICAL CONTROL

## ALL WRITTEN DIMENSIONS TAKE PRECEDENCE OVER SCALE. BUILDER TO VERIFY ALL DIMENSIONS PRIOR TO COMMMENCING CONSTRUCTION. NOTIFY DESIGNER OF ANY DISCREPANCIES BEFORE PROCEEDING PROPOSED NEW RESIDENCE

**SORENSEN CALDON** 

PETER NIKSIC DESIGN & DRAFTING

DOMESTIC, SOLAR PASSIVE DESIGN,

MOBILE: 0421 749 553


**FERRIS BUILDERS** CUSTOM DESIGN HOMES Taree Office (02) 6551 0445


EST 1958

FOR Mr. & Mrs. Griffin AT Lot 1, No.7, Ferry Road, Croki. N.S.W. 2430 D.P.770821

BASIX CERT. No.	SCALE	1:100
	DATE	12-08-25
PLAN C. I. D. :	DRAWN	Author
Custom Design	CHECKED	Approver
TITLE ELEVATIONS	JOB No.	DWG No.

RL. 9.350 m

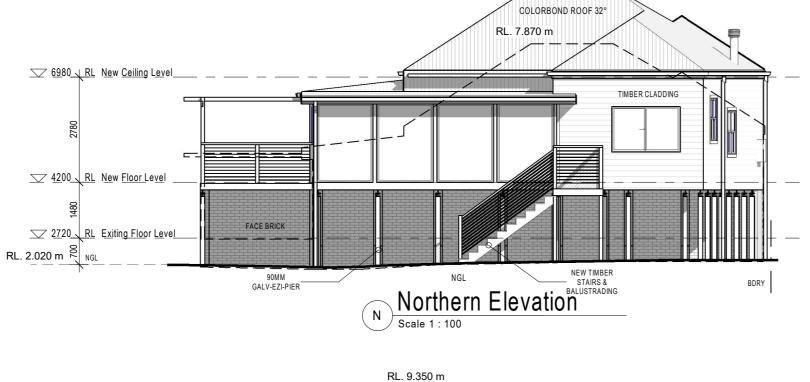

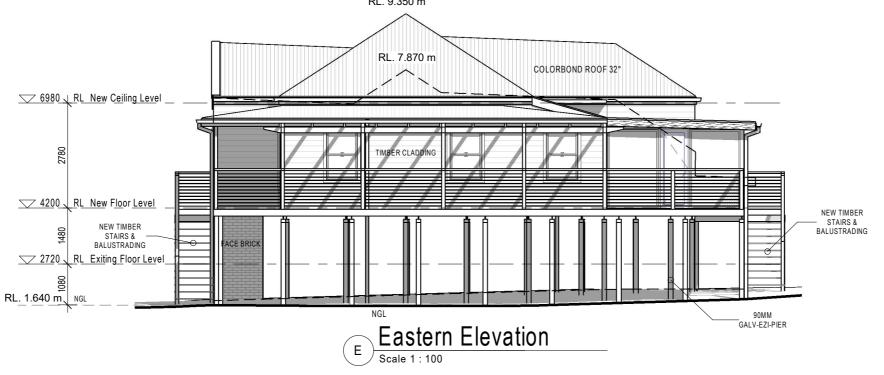

PETER NIKSIC DESIGN & DRAFTING

DOMESTIC, SOLAR PASSIVE DESIGN,

MOBILE: 0421 749 553

350P	350mm ENGAGED BRICK PIERS @ 1500 CTRS MAX.	
AC	AIR CONDITIONER CONDENSOR	
BAL	1000mm HIGH BALUSTRADE	
BG		
	BOX GUTTER TO DETAIL	
BOE	BRICK ON EDGE	
BW	BRICKWORK - REFER TO EXTERNAL FINISHES SCHEDULE FOR SPEC.	
BWR	BRICKWORK RENDERED- REFER TO EXTERNAL FINISHES SCHEDULE FOR SPEC.	
СВ	CORBEL BRICK BAND-PROJECTION AS NOTED	
CCO	COLOURED CONCRETE - REFER TO EXTERNAL FINISHES SCHEDULES FOR SPEC.	
CWL	ROOF COWL	
DEB	DROP EDGE BEAM TO STRUCTURAL ENGINEER'S DETAIL	
DP	DOWNPIPE	
DPS	DOWNPIPE & SPREADER	
EGL	EXISTING GROUND LINE	
EXH/E	EXHAUST VENT TO EAVE	
EXH/W	EXHAUST VENT TO WALL	
FCL	FINISHED CEILING LEVEL	
FFL	FINISHED FLOOR LEVEL	
FL	FLASHING - REFER TO EXTERNAL FINISHES SCHEDULE FOR SPEC	
FGL	FINISHED GROUND LEVEL	
FSL	FINISHED SLAB LEVEL	
GB	GLASS BLOCKS - NON-FIRE RATED	
GBR	GLASS BLOCKS - FIRE RATED	
GDP	GARAGE DOOR - PANELLED	
GFL	GARAGE FLOOR LEVEL	
GM	GAS METER	
HRL	1000mm HIGH HANDRAIL	
HWU	HOT WATER SERVICE	
JUL	METAL FRAMED JULIET BALCONY	
LWC	LIGHTWEIGHT CLADDING - REFER TO EXTERNAL FINISHES SCHEDULES FOR SPEC.	
MB	RECESSED ELECTRICAL METER BOX	
MR-3°	METAL ROOF - PITCH AS NOTED	
OF	OVERFLOW	
O/H	OVERHANG - LENGTH AS NOTED	
P	PAVING-REFER TO EXTERNAL FINISHES	
	SCHEDULE FOR SPEC.	
RB-90	90mm RECESSED BRICKWORK	
RCF	REINFORCED CONCRETE FOOTING TO	
	STRUCTURAL ENGINEER'S DETAILS	
RCS	REINFORCED CONCRETE SLAB TO STRUCTURAL ENGINEER'S DETAIL	
RWO	RAIN WATER OUTLET	
SC	BRICK SOLDIER COURSE	
S/D	SETDOWN	
SP	STEEL POST TO ENGINEER'S DETAIL	
TD	TIMBER DECK	
TFJ	TIMBER FLOOR JOISTS TO MANUFACTURER'S SPECIFICATION	
TP	TIMBER POST-(REFER TO ENG'S DWG.)	
TPG	TIMBER PERGOLA TO DETAIL	
TR-25°	TILED ROOF - PITCH AS NOTED	
TS	TIMBER STAIRS AND LANDING	
TTR	TIMBER TRUSSED ROOF TO MANUFACTURERE'S SPECIFICATION	
	VERTICAL CONTROL JOINT	
VJ VJ-F		

LEGEND

ALL WRITTEN DIMENSIONS TAKE PRECEDENCE OVER SCALE. BUILDER TO VERIFY ALL DIMENSIONS PRIOR TO COMMMENCING CONSTRUCTION. NOTIFY DESIGNER OF ANY DISCREPANCIES BEFORE PROCEEDING				
		DDODOCED NEW DECIDENCE	DACIV CERT No	SCALE

**SORENSEN CALDON FERRIS BUILDERS** 

EST 1958

Taree Office (02) 6551 0445

FOR Mr. & Mrs. Griffin AT Lot 1, No.7, Ferry Road, Croki. N.S.W. 2430 D.P.770821

PROPOSED NEW RESIDENCE

BASIX CERT. No.	SCALE	1:100
	DATE	12-08-25
PLAN	DRAWN	Author
Custom Design	CHECKED	Approver
TITLE	JOB No.	DWG No.
ELEVATIONS		04

REINFORCED CONCRETE SLAB ACCORDING TO ENGINEERS DETAILS AND COMPLYING WITH AS 2870 - RESIDENTIAL SLABS AND FOOTINGS & AS 3660 - CONCRETE STRUCTURES.

## TERMITE PROTECTION

POUR REINFORCED CONCRETE FLOOR SLAB IN ACCORDANCE WITH AS 2870 TO FORM PART OF THE TERMITE BARRIER. PROTECT IN ACCORDANCE WITH AS 3660-1 AND ACCORDING TO MANUFACTURER'S INSTRUCTIONS.

### PEST CONTROL SYSTEM

PEST CONTROL SYSTEM – PHYSICAL TERMITE MANAGEMENT SYSTEM INSTALLED IN ACCORDANCE WITH MANUFACTURERS INSTRUCTIONS

ISSUE TO COUNCIL

REV DESCRIPTION

PREFABRICATED TIMBER WALL FRAMES & TRUSSES TO SUIT A DESIGNED WIND SPEED UP TO N3

WC-TILES TO FLOOR & SINGLE ROW SKIRTING (MAX 250MM HIGH) SINGLE ROW OVER VANITY

BATHROOM-TILES TO FLOOR & WALL TILES FROM FLOOR TO CEILING

ENS-TILES TO FLOOR, 1200HIGH WALL TILE WITH SHOWER RECESS MAX 2.1M HIGH.

LDRY-TILES TO FLOOR & SINGLE ROW SKIRTING (MAX 250MM HIGH) & 400MM HIGH SPLASHBACK TO TUB & WASHING MACHINE

KITCHEN- 600MM HIGH CERAMIC TILING OVER BENCH TOPS TO

NOTE: 90MM PLASTERBOARD CORNICES

NOTE: INSECT SCREENS TO AUMINIUM WINDOW & SLIDING GLASS DOOR OPENING SASHES

"SPLASH BACK WINDOW TO SITE ON BENCH TOP. UNDER SIDE OF ALUMINIUM IS 903MM + FLOOR FINISH, ALLOW 50MM CLEARANCE TOP AND BOTTOM FOR BENCH TOP AND BASE PANEL OF OVERHEADS. REVEALS ONLY TO SIDES, NO TOP & BOTTOM REVEALS."

## **GENERAL NOTES**

GLAZING TO COMPLY WITH PARTS 8.2.2, 8.3.3 AND PART 8.4 OF THE HOUSING PROVISIONS FOR GLAZING HUMAN IMPACT.

THE BUILDING WILL COMPLY WITH AS3740 & PART 10.2 OF THE HOUSING PROVISIONS. H4P1 WET AREAS WILL BE PROTECTED IN ACCORDANCE WITH 10.2.1 TO 10.2.6 AND 10.2.12. DETAILS AND SET OUT PLAN FOR PROPOSED WET AREAS ON SLAB LAYOUT COMPLY WITH PART 10.2 OF NCC 2022 HOUSING

MECHANICAL VENTILATION TO WC AND KITCHEN WITH EXTERNAL DISCHARGE LOCATION AS PER NCC H4D7 - VENTILATION.

MASONRY ARTICULATION JOINTS AS PER AS 4773.2 & NCC H1D5.

ALL GLAZING WILL BE INSTALLED IN ACCORDANCE WITH AS1288-2021.

WATERPROOFING WILL BE INSTALLED IN ACCORDANCE WITH THE NEW WATERPROOFING STANDARD AS 3740-2022.

LIFT OFF HINGES WILL BE INSTALLED TO W.C.

ALL PROPOSED WORKS WILL COMPLY WITH BCA VOLUME 2 2022.

### GENERAL NOTES

ARCHITECTURAL DRAWINGS TO BE READ IN CONJUNCTION WITH STRUCTURAL ENGINEERS DRAWINGS AND ALL OTHER RELEVANT CONSULTANTS DRAWINGS.

ALL DIMENSIONS TO BE VERIFIED BEFORE ANY WORK OR FABRICATION COMMENCES.

IF ANY DISCREPANCY, AMBIGUITY, ERROR OR INCONSISTANCY IS FOUND IN THIS SET OF DRAWINGS, REPORT TO SCF BUILDERS BEFORE PROCEEDING.

IALL WORKS TO BE CARRIED OUT IN ACCORDANCE WITH THE RELEVANT CURRENT AUSTRALIAN STANDARDS AND THE BUILDING CODE OF AUSTRALIA UNLESS OTHERWISE SPECIFIED

TIMBER FRAMINGTO BE IN ACCORDANCE WITH AS1684. NATIONAL TIMBER FRAMING

SUB-FLOOR VENTILATION TO COMPLY WITH PART 3.4.1 BCA VOL. TWO

WHERE ROOF TRUSSES ARE NOMINATED DESIGN & SPECIFICATION TO BE BY MANUFACTURER.

BALISTRADES TO COMPLY WITH BCA PART

POOL SAFETY FENCE TO COMPLY WIT AS1926.1 & SWIMMING POOLS ACT

INSTALLATION OF SMOKE DETECTORS TO COMPLY WITH AS3786.

PLUMBING & DRAINAGE SYSTEMS TO COMPLY WITH AS/NZS3500

TERMITE MANAGEMENT SYSTEMS TO COMPLY WITH AS3660.1

CONCRETE CONSTRUCTION TO BE IN ACCORDANCE WITH AS3600.

MASONRY CONSTRUCTION TO BE IN ACCORDANCE WITH AS3700

DAMP-PROOF COURSE & FLASHINGS TO BE IN ACCORDANCE WITH AS/NZS 2904.

UNPLASTICISED PVC (UPVC) DOWNPIPE & FITTINGS FOR RAINWATER TO COMPLY WITH

INSTALLATION OF SHEET ROOF & WALL CLADDING TO COMPLY WITH AS1562.1

ALL PEDESTRIAN SURFACES TO COMPLY WITH AS4586 & AS 1428.1

SKYLIGHTS TO BE INSTALLED IN ACCORDANCE WITH AS4285 & AS3959 ( BUILDING IN BUSHFIRE PRONE AREAS).

GLASS TO BE SELECTED & INSTALLED IN ACCORDANCE WITH AS1288 & AS 2047.

WATERPROOFING OF WET AREAS TO COMPLY WITH AS3740 & AS1684

ELECTRICAL INSTALLATIONS TO COMPLY WITH AS/NZS3000

PLEASE NOTE: THE STANDARDS REFERENCED IN THE TABLE ARE THE RELEVANT VERSION ADOPTED BY THE BCA AT THE TIME THE CONSTRUCTION CERTIFICATE OR COMPLYING DEVELOPEMNT CERTIFICATE APPLICATION WAS

# THIS DRAWING REMAINS THE PROPERTY OF SORENSEN CALDON FERRIS BUILDERS AND IS PROVIDED FOR THE USE COPYRIGHT 2025 AS DESCRIBED AND MAY NOT BE USED OR REPRODUCED IN WHOLE OR IN PART WITHOUT WRITTEN PERMISSION ALL WRITTEN DIMENSIONS TAKE PRECEDENCE OVER SCALE. BUILDER TO VERIFY ALL DIMENSIONS PRIOR TO COMMMENCING CONSTRUCTION. NOTIFY D

12-08-25

DATE

# PETER NIKSIC DESIGN & DRAFTING DOMESTIC, SOLAR PASSIVE DESIGN,

MOBILE: 0421 749 553

## EST 1958 **SORENSEN CALDON FERRIS BUILDERS**

CUSTOM DESIGN HOMES Taree Office (02) 6551 0445 FOR Mr. & Mrs. Griffin

PROPOSED NEW RESIDENCE

AT Lot 1, No.7, Ferry Road, Croki. N.S.W. 2430 D.P.770821

DESIGNER OF ANY DISCREPANCIES BEFORE PROCEEDING				
	BASIX CERT. No.	SCALE	1:100	
		DATE	12-08-25	
	PLAN Custom Design	DRAWN	Author	
		CHECKED	Approver	
	TITLE SECTIONS	JOB No.	DWG No.	

